GENERAL NOTES

- CONTRACTOR SHALL BE RESPONSIBLE FOR PROVIDING ALL NECESSARY FITTINGS AS REQUIRED BY ALL APPLICABLE CODES AND GOVERNING AUTHORITIES.
- 2. CONTRACTOR SHALL VERIFY AND CORRECT AS REQUIRED TO MEET ALL CODES AND REGULATIONS ANY POSSIBLE DISCREPANCIES BETWEEN TYPE AND SIZE OF CONNECTION SPECIFIED IN PLUMBING FIXTURE SCHEDULE AND FIXTURES ACTUALLY INSTALLED ON THE SITE.
- 3. ALL SANITARY 1/8" AND GREASE WASTE PIPING SHALL HAVE A 1/4" PER FOOT SLOPE UNLESS OTHERWISE NOTED OR PER LOCAL CODE.
- 4. CONTRACTOR SHALL COORDINATE ALL WORK WITH OTHER TRADES.
- 5. CONTRACTOR SHALL FIELD VERIFY ALL GIVEN MEASUREMENTS PRIOR TO LAYING AND CONNECTING ALL SANITARY AND WASTE PIPING AND NOTIFY ARCHITECT OF ANY DISCREPANCIES.
- 6. CONTRACTOR SHALL BE RESPONSIBLE FOR MAINTAINING FIRE RATING AND WEATHERPROOFING INTEGRITY OF ALL PIPING AND PENETRATIONS.
- 7. ALL SANITARY LINES SHALL BE RUN AS CLOSE TO PLANS AS POSSIBLE WITH NO CHANGES IN SIZING.
- 8. CONTRACTOR SHALL BE RESPONSIBLE FOR PROVIDING ALL NECESSARY SUPPORTING DEVICES FOR ALL FIXTURES INCLUDED IN CONTRACT OR HEREIN SPECIFIED OR OTHERWISE.
- 9. CHANGES IN THE DIRECTION OF SANITARY PIPING SHALL NOT BE MADE WITH FITTINGS WHICH WILL CAUSE EXCESSIVE REDUCTION IN THE VELOCITY OF FLOW OR CREATE ANY OTHER ADVERSE EFFECT UNLESS PHYSICALLY IMPOSSIBLE (IE: USE OF SANITARY TEE IN A HORIZONTAL CONNECTION, USE OF A DOUBLE SANITARY TEE IN A VERTICAL STACK, IN GENERAL, USE OF SHORT-RADIUS FITTINGS FOR BRANCH TO HOUSE DRAIN OR STACK CONNECTION).
- ALL DRAINAGE PIPING SHALL BE MARKED WITH THE SEAL OF APPROVAL OF THE NATIONAL SANITATION FOUNDATION.
- 11. SEE ARCHITECTURAL DRAWINGS FOR EXACT LOCATIONS OF PLUMBING FIXTURE MOUNTING HEIGHTS, AND DIMENSIONS.
- 12. CONTRACTOR SHALL VERIFY INVERT ELEVATIONS OF SANITARY AND GREASE TRAPS TO WHICH NEW SEWER LINES ARE TO BE CONNECTED BEFORE INSTALLATION OF NEW SEWER LINE.
- 13. ALL VENTS THROUGH ROOF SHALL BE MIN. 10'-0" FROM ANY AIR INTAKES.
- 14. CONTRACTOR SHALL SUBMIT SHOP DRAWINGS (INCLUDING PIPE ROUTING AND EQUIPMENT LOCATIONS) TO ARCHITECT/ENGINEER FOR REVIEW AND APPROVAL PRIOR TO THE INSTALLATION OR PURCHASING OF ANY PIPING AND/OR EQUIPMENT.
- 15. CLEANOUTS SHALL BE PROVIDED AT THE LOCATIONS INDICATED AND A MINIMUM WHERE REQUIRED BY CODE. FLOOR CLEANOUTS SHALL BE A MINIMUM OF 4" AND SHALL BE COMPLETE WITH A FLUSH PLUG AND REMOVABLE SCORIATED BRONZE FLOOR PLATE, PROVIDE CARPET BUTTONS IN CARPETED AREAS.

FOOD SERVICE NOTES

- ALL HORIZONTAL PIPING LINES EXTENDED AND CONNECTED TO EQUIPMENT, BELOW EQUIPMENT, SHALL BE RUN AT THE HIGHEST POSSIBLE ELEVATION ABOVE FLOOR, TO PROVIDE CLEARANCE FOR CLEARING. NO LINES SHALL LAY ON FLOOR.
- ALL PIPING ROUTED THROUGH OR NEAR EQUIPMENT OR COUNTERS SHALL NOT INTERFERE WITH THE INTENDED USE OF, OR SERVICING OF, EQUIPMENT OR COUNTERS.
- 3. ALL EXPOSED PIPING AND FITTINGS SHALL BE CHROME PLATED OR STAINLESS STEEL. TAIL PIECES FOR SINKS SHALL BE 17 GAUGE CHROME PLATED FLARED BRASS TUBING FOR CONNECTION TO 1-1/2" I.P.S. MALE THREAD FITTING. "P" TRAPS SHALL BE CHROME PLATED BRASS, UNIFORM CODE PATTERN.
- 4. KITCHEN EQUIPMENT DIVISION SHALL PROVIDE ALL FOOD SERVICE EQUIPMENT FAUCETS. PLUMBING CONTRACTOR SHALL INSTALL AND CONNECT. EQUIPMENT SINKS ARE PROVIDED WITH 1-1/2" WASTE CONNECTIONS.
- 5. ALL WASTES, DIRECT OR INDIRECT, SHALL BE FURNISHED AND INSTALLED BY THE PLUMBING CONTRACTOR EXCEPT AS NOTED ON UTILITY PLANS.
- 6. MINIMUM SIZE INDIRECT WASTES SHALL BE 1", REGARDLESS OF SIZE OF CONNECTION AT EQUIPMENT.
- 7. ADEQUATE CLEAN-OUT PROVISION SHALL BE MADE FOR ALL WASTE LINES BY MEANS OF PLUGGED "T" FITTING EXTENDED TO ACCESSIBLE POSITION.
- 8. PLUMBING CONTRACTOR SHALL FURNISH AND INSTALL DRAIN LINES FROM COLD STORAGE ROOM EVAPORATORS TO DRAIN LOCATIONS WITH MINIMAL PITCH AND "P" TRAP IN END OVER FLOOR RECEPTOR DRAIN LINES SHALL BE 1" MINIMUM. EACH EVAPORATOR SHALL HAVE A SEPARATE DRAIN LINE.
- 9. PLUMBING CONTRACTOR SHALL COORDINATE WITH KITCHEN CONSULTANT DRAWINGS FOR ROUGH IN LOCATIONS, SIZES AND HOOK-UP REQUIREMENTS FOR ALL KITCHEN EQUIPMENT. ROUGH IN EQUIPMENT PER MANUFACTURERS RECOMMENDATIONS.

FIELD VERIFY ALL CONDITIONS

NOTE! AS NOTED IN THE SPECIFICATIONS, ALL WIRING LAYOUTS, PIPING LAYOUTS AND DUCT LAYOUTS ARE SCHEMATIC. EXACT LOCATIONS SHALL BE DETERMINED BY THE CONSTRUCTION AND STRUCTURE OF THE BUILDING AND SHALL BE VERIFIED AND COORDINATED IN THE FIELD. EACH TRADE CONTRACTOR SHALL VERIFY WITH THE GENERAL CONTRACTOR THAT HE HAS THOROUGHLY REVIEWED AND COORDINATED ALL LOCATIONS AND ROUTINGS WITH ALL OTHER TRADES PRIOR TO FABRICATION OF CONDUITS, DUCTS, OR PIPING, AND START OF INSTALLATION OF SAME (INCLUDING SPRINKLER PIPING WHEN PRESENT ON JOB). ANY INSTALLATION OR CONSTRUCTION CONFLICTS WHICH OCCUR IN THE FIELD SHALL BE RESOLVED BY THE TRADE CONTRACTOR TO THE SATISFACTION OF THE OWNER AND ARCHITECT AND AT NO EXPENSE TO THE OWNER, ARCHITECT AND/OR GENERAL CONTRACTOR.

THE CONTRACTOR SHALL CONTACT THE ARCHITECT, ENGINEER OR OWNER PRIOR TO BIDDING FOR INTERPRETATIONS AND CLARIFICATIONS OF THE DESIGN AND INCLUDE IN HIS BID ALL COSTS TO MEET THE DESIGN INTENT. CLARIFICATIONS MADE BY THE ARCHITECT, ENGINEER OR OWNER AFTER BIDDING WILL BE FINAL AND SHALL BE IMPLEMENTED AT CONTRACTORS COST.

BIDDING CONTRACTORS SHALL HAVE A WORKING KNOWLEDGE OF LOCAL CODES AND ORDINANCES AND SHALL INCLUDE IN THEIR BIDS THE COSTS FOR ALL WORK INSTALLED IN STRICT ACCORDANCE WITH GOVERNING CODES, THE PLANS AND SPECIFICATIONS NOT WITHSTANDING. THE CONTRACTOR SHALL ALERT ARCHITECT, ENGINEER OR OWNER OF ANY APPARENT DISCREPANCIES BETWEEN GOVERNING CODES AND DESIGN INTENT.

1

SCOPE OF WORK

PROPOSING RENOVATION TO EXISTING RESTAURANT. WORK TO INCLUDE OF LEGALIZATION OF EXISTING FOG SYSTEM.

_

PLUMBING LEGEND

→ DIRECTION OF FLOW IN PIPE→ PITCH PIPE DOWN IN DIRECTION OF ARROW

——O—O PIPE UP

— 😄 🗇 PIPE DOWN

EXISTING GREASE WASTE (BELOW GRADE)

POINT OF CONNECTION NEW TO EXISTING

FS-1 (FLOOR SINK 1/2 GRATE)

— — — EXISTING VENT PIPE

FD FLOOR DRAIN
HD O HUB DRAIN

TD TRENCH DRAIN

TRENCH DRAIN


FLOOR CLEANOUT

FXTERIOR CLEANO

EXTERIOR CLEANOUT
HORIZONTAL CLEANOUT

AB	BREVIATIONS
SAN	SANITARY
GW	GREASE WASTE
V	VENT
AFF/AFG	ABOVE FINISHED FLOOR/GRADE
AHJ	AUTHORITY HAVING JURISDICTION
ETR	EXISTING TO REMAIN
FCO	FLOOR CLEANOUT
GC	GENERAL CONTRACTOR
IW	INDIRECT WASTE
PC	PLUMBING CONTRACTOR
WCO	WALL CLEANOUT
FD	FLOOR DRAIN
HD	HUB DRAIN
FS	FLOOR SINK
TD	TRENCH DRAIN
F	FRANCHISE
EV	EQUIPMENT VENDOR
CC	CONTRACTORS CHOICE
ОС	OWNERS CHOICE
VLL	VERIFY WITH LANDLORD
SPS	SEE PLUMBING SCHDULE
FCO	FLOOR CLEANOUT
GAL	GALLONS
GPM	GALLON PER MINUTE
DFU	DRAINAGE FIXTURE UNITS

SHEET LIST	
SHEET NUMBER	SHEET TITLE
PLUMBING	
P-1	GENERAL NOTES AND LEGEN
P-2	PLUMBING SANITARY PLAN
P-3	PLUMBING DETAILS - 1
P-4	PLUMBING DETAILS - 2

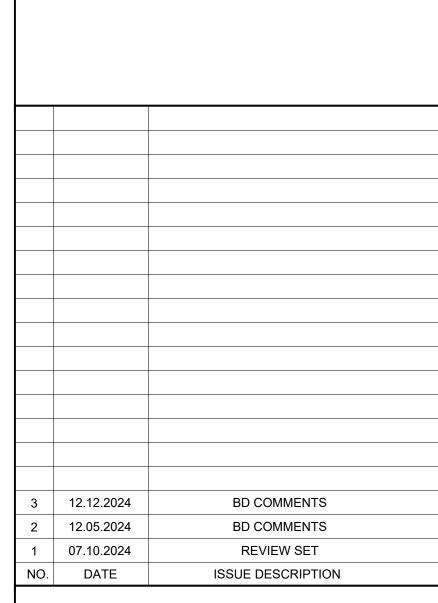

NY ENGINEERS

NEARBY ENGINEERS
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KEY PLAN

PROJECT NAME

PHYSICAL LOCATION

DRAWING TITLE

GENERAL NOTES, ABBREVIATIONS AND LEGENDS.

RAPHIC SCALE

0 1/8" 1/4" 1/2" 1"

PROJECT NO.

SCALE

AS NOTED

DRAWN BY

NYE

CHECKED BY

NYE

DATE

07/10/2024

SHEET NUMBER

THIS PLAN IS APPROVED ONLY FOR THE WORK INDICATED ON THE APPLICATION SPECIFICATION SHEET. ALL OTHER MATTERS SHOWN ARE NOT TO BE RELIED UPON, OR BE CONSIDERED AS BEING APPROVED OR IN ACCORDACE WITH APPLICABLE CODES

KEYED NOTES $\langle \# \rangle$

- 1. EXISTING RESTROOM FIXTURES WITH EXISTING SANITARY, VENT AND ASSOCIATED ACCESSORIES AND FITTINGS TO REMAIN. CONTRACTOR TO FIELD VERIFY EXISTING CONDITION OF FIXTURES AND PIPING, REPLACE IF REQUIRED.
- 2. EXISTING FLOOR SINK AND FLOOR DRAIN WITH EXISTING SANITARY, VENT AND ASSOCIATED ACCESSORIES AND FITTINGS TO REMAIN. CONTRACTOR TO FIELD VERIFY EXISTING CONDITION OF PIPING, REPLACE IF REQUIRED.
- 3. EXISTING HAND SINK WITH EXISTING SANITARY, VENT AND ASSOCIATED ACCESSORIES AND FITTINGS TO REMAIN. CONTRACTOR TO FIELD VERIFY EXISTING CONDITION OF PIPING, REPLACE IF REQUIRED.
- 4. EXISTING MOP SINK WITH EXISTING SANITARY, VENT AND ASSOCIATED ACCESSORIES AND FITTINGS TO REMAIN. CONTRACTOR TO FIELD VERIFY EXISTING CONDITION OF PIPING, REPLACE IF REQUIRED.
- 5. EXISTING GREASE INTERCEPTOR AND SOLID INTERCEPTOR WITH SANITARY, VENT AND ASSOCIATED ACCESSORIES AND FITTINGS TO REMAIN. CONTRACTOR TO FIELD VERIFY EXISTING CONDITION OF INTERCEPTOR AND PIPING, REPLACE IF REQUIRED. NOTIFY THE ENGINEER IF ANY DISCREPANCIES IN THE FILED.
- 6. CONDENSATE DISPOSAL FROM EXISTING WALK IN COOLER AND FREEZER TO ADJACENT EXISTING FLOOR SINK OR EXISTING MOP SINK WITH APPROVED AIR GAP.
- 7. ANY UNUSED PLUMBING EQUIPMENT, PIPING, ETC., WITHIN OR SERVING THE PREMISES MUST BE COMPLETELY REMOVED TO POINT OF ORIGIN AND CAPPED. DO NOT ABANDON IN PLACE.
- 8. CONTRACTOR TO FIELD VERIFY AVAILABILITY OF SAMPLING PORT. PROVIDE NEW (SCHIER SV-10) AS SHOWN ON THE PLAN IF NOT EXISTING. REFER SHEET P-5 FOR MORE DETAIL. BASE BID ACCORDINGLY.

GENERAL NOTES

- 1. ALL PIPING SHALL BE SNAKE CLEAN PRIOR TO CONNECTION. 2. ANY CHANGES AND/ OR UPGRADES TO TENANT'S EXISTING PLUMBING SYSTEMS SHALL COMPLY WITH ALL CODES AND MALL CRITERIA. EXISTING SYSTEMS SHALL POSSESS THE CAPACITY TO
- HANDLE ANY AND ALL CHANGES IN LOAD. 3. ALL DRAIN, WASTE AND VENT FITTINGS SHALL BE CAST IRON PIPE.
- 4. PLUMBING IS NOT PERMITTED IN ANY DEMISING PARTITIONS. FURROUT THE WALL AS NECESSARY. 5. EXHAUST AND PLUMBING VENTS SHALL BE LOCATED A MINIMUM OF 10'-0"AWAY FROM ANY OUTSIDE
- AIR INTAKE, AND 5'-0"FROM ANY DEMISING WALL VERTICAL PLANE. 6. ALL FLOOR DRAINS ARE REQUIRED TO HAVE TRAP PRIMERS.
- 7. ANY UNUSED PLUMBING EQUIPMENT, PIPING, ETC., WITHIN OR SERVING THE PREMISES MUST BE COMPLETELY REMOVED TO POINT OF ORIGIN. DO NOT ABANDON IN PLACE. 8. ALL FLOOR PENETRATIONS MUST BE CORE BORED, SLEEVED, GROUTED, SEALED AND MADE
- WATERPROOF. SLEEVES MUST EXTEND A MINIMUM OF 4"AFF. 9. IF NOT ALREADY EXISTING, INSTALL A SHUT OFF VALVE ON DOMESTIC WATER LINE INSIDE SPACE. 10. TENANT IS REQUIRED TO INSTALL A WATERPROOF MEMBRANE IN ALL WET AREAS OF THE SPACE. TENANT SHALL USE A 30 MIL POLYETHYLENE CLEAVAGE MEMBRANE (EQUAL TO NOBLESEAL TS) INSTALLED PER MANUFACTURERS RECOMMENDATIONS AND ANSI A108. MEMBRANE MUST BE
- EXTENDED UP THE WALL A MINIMUM OF 6"OR EQUAL TO THE HEIGHT OF THE FLOOR BASE. 11. SLOPE OF DRAINAGE SYSTEM SHALL BE 1/8" PER FOOT FOR SANITARY & $\frac{1}{4}$ " PER FOOT OF RUN FOR GREASE WASTE FOR PIPE 3" AND ABOVE. 1/4" PER FOOT OF RUN FOR PIPE LESS THAN 3". VENT
- PIPING SHALL BE PITCHED TO DRAIN.

	12.	PROVIDE ACCESS PANEL FOR CLEANOUTS AND ALL CONCEALED EQUIPMENTS THAT REQUIRE MAINTENANCE ACCESS. CONTRACTOR TO COORDINATE WITH ARCHITECT FOR LOCATION.
\		
7		

EQUIPMENT SCHEDULE												
EQ. TAG.	QTY.	EQUIPMENT CATEGORY	COLD WATER SIZE (IN)	HOT WATER SIZE (IN)	DIRECT DRIAN SIZE (IN)	INDIRECT DRIAN SIZE (IN)	MBTUH	GAS SIZE (IN)	PLUMBING REMARKS			
1	3	FRYER, DEEP FAT GAS W/FILTER	-	-	-	-	-	-	REFER KITCHEN EQUIPMENT SCHEDULE			
2	1	GRIDLER	-	-	-	-	-	-	REFER KITCHEN EQUIPMENT SCHEDULE			
3	1	BURNER	-	-	-	-	-	-	REFER KITCHEN EQUIPMENT SCHEDULE			
4	1	WOK	-	-	-	-	-	-	REFER KITCHEN EQUIPMENT SCHEDULE			
5	1	3-COMPARTMENT SINK - EXISTING	E	E	-	E	-	-	-			
6	2	HAND SINK - EXISTING	E	E	-	E	-	-	-			
7	1	MOP SINK - EXISTING	Е	E	-	Е	-	-	-			

GREASE INTERCEPTOR CALCULATIONS											
EQ. TAG	FIXTURE TYPE	COMPARTMEN T QUANTITY	L	W	D	VOLUME (CU. IN.)	VOLUME (GALLONS)	% FULL	DRAIN TIME (MINUTES)	DRAINAGE LOAD (GALLONS)	
05	3-COMP SINK	3	18	18	14	13608	58.9	0.75	2	22.1	
08	MOP SINK	1	24	20	10	4800	20.8	0.75	2	7.8	
06	HAND SINK	2	10	14	5	1400	6.1	0.75	2	2.3	
EX.FD	FLOOR DRAIN	2	-	-	-	-	-	0.75	2	2.00	
~~	~~~	~~~	~		~	,	TOTAL FIXTU	RE FLOW	/ RATE (GPM):	34.20	
EQ.TAG	FI	XTURE TYPE				QUANTITY	FLOW	CAPACIT	Y (GPM)	FLOW RATE (GPM)	
EX.FS	F	LOOR SINK				4		0.25		1.00	
-							MAXIM	JM FLOV	V RATE (GPM):	35	

FOG LOAD		
NO OF SEATS	7	YELLOW GREASE CAL
SEATING ROTATIONS	4	NO OF FRYERS (QTY.)
MEALS FROM SEATS	28	OIL CAPACITY OF EACH FRYER (GALLONS)
TAKE OUT MEALS	100	OIL CHANGE FREQUENCY (DAYS)
TOTAL MEALS	128	YELLOW GREASE GENERATED IN A WEEK (GAL P
POUNDS FOG / MEAL = 0.025 POUNDS / MEALS, HIGH GREA	ASE NO FLATWARE	YELLOW GREASE GENERATED IN A MONTH (GAL
POUNDS FOG / DAY = 3.20		

GREASE PRODUCTION FOR 30 DAYS = 96 FOG LBS

GREASE PRODUCTION FOR 60 DAYS = 192 FOG LBS SELECTED MODEL - SCHIER GB-2

FOG CAPACITY @ 99% - 180 LBS

PUMP OUT FACTOR SELECTED - 30 DAYS

YELLOW GREASE CALCULATION & STORAG	GE CAPACITY
NO OF FRYERS (QTY.)	3
OIL CAPACITY OF EACH FRYER (GALLONS)	6.8
OIL CHANGE FREQUENCY (DAYS)	4
YELLOW GREASE GENERATED IN A WEEK (GAL PER WEEK)	35.7
YELLOW GREASE GENERATED IN A MONTH (GAL PER MONTH)	142.8

IF OIL CHANGE FREQUENCY IS 4 DAYS, WE'RE USING 20.4 GALLONS EVERY 4 DAYS. TO FIND THE WEEKLY USAGE, WE

PROPOSED CAPACITY OF TANK IS 200 GALLONS OR 1500 LBS

SELECTED FLOW RATE: 35 GPM

FREQUENCY OF EMPTING OF THE STORAGE CONTAINER AT 90% CAPACITY IS 30 DAYS. SUMMARY: WITH 3 FRYERS, EACH WITH A CAPACITY OF 6.8 GALLONS, TOTAL CAPACITY IS 3 FRYERS * 6.8 GALLONS/FRYER = 20.4 GALLONS.

CAN DIVIDE 7 DAYS BY 4 DAYS/CHANGE TO SEE HOW MANY CHANGES OCCUR IN A WEEK: CHANGES OCCUR IN A WEEK 7 DAYS / 4 DAYS/CHANGE = 1.75 CHANGES.

SO, IN A WEEK, WE'RE USING 1.75 CHANGES * 20.4 GALLONS/CHANGE = 35.7 GALLONS OF OIL PER WEEK.

CONSIDERING 4 WEEKS IN A MONTH TOTAL GALLONS IS 35.7 GALLONS * 4 WEEKS = 142.8 GALLONS

	GREASE AND SOLID INTERCEPTOR SCHEDULE - EXISTING									
	PER PDI G-101 STANDARDS									
TAG NO DESCRIPTION QTY INLET / OUTLET SIZE (INCHES) FLOW RATE (GPM) WATER (GAL) GREASE (LBS) (GAL) MANUFACTURER AND MODEL REMARK							REMARKS			
EX.GI	EXISTING GREASE INTERCEPTOR	2	4"	35 / 50 GPM	24.7	180	1.8	SCHIER GB-2	EXISTING TO REMAIN	
EX.SI	EXISTING SOLID INTERCEPTOR	1	3"	35 GPM	16	-	2	STRIEM AARDVARK AA-S	EXISTING TO REMAIN	

COOKING OIL TANK SCHEDULE								
TAG NO	DESCRIPTION	QTY	STORAGE (GAL)	GREASE (LBS)	MANUFACTURER AND MODEL	DIMIENSIONS	REMARKS	
ST-1	YELLOW GREASE STORAGE TANK	1	200	1500	MAHONEY	31" DIA X 87.5" HEIGHT	TANK CONNECTIONS AS PER MANUFACTURER RECOMMENDATIONS	

03 (02)— EXISTING GREASE INTERCEPTOR PIT EX.FS(2) SAMPLING 8 \blacksquare EX.FD $\langle 2 \rangle$ EXISTING 4" GREASE OUTLET FCO EX. 4" GW [」]EX. 4" GW TO SANITARY SYSTEM -WASH-DOWN KITCHEN FIXTURE PROPOSED 200 GALLONS YELLOW 3 EX.HS GREASE STORAGE TANK (ST-1) (BY OWNER) 08 EX.MS 4 5——————— EXISTING V.T.R TO REMAIN WALK IN COOLER CASH COUNTER **EXISTING** WALK IN FREEZER 3 12.12.2024 12.05.2024 07.10.2024 REST ROOM ISSUE DESCRIPTION NO. DATE **NEARBY ENGINEERS** 382 NE 191ST STREET SUITE 49674, MIAMI, FL 33179 **PLUMBING SANITARY PLAN** PH-914.257.3455 WWW.NY-ENGINEERS.COM KEY PLAN PROJECT NAME INTERCEPTOR PIT PHYSICAL LOCATION –SAMPLING PORT (VIF) \langle 8 angleEXISTING 4" GREASE OUTLET TO SANITARY SYSTEM EXISTING V.T.R TO (41 DFU) REMAIN [\]-41 DFU DRAWING TITLE PLUMBING SANITARY RISER

P1.0 N.T.S PLUMBING SANITARY PLAN

> THIS PLAN IS APPROVED ONLY FOR THE WORK INDICATED ON THE APPLICATION SPECIFICATION SHEET. ALL OTHER MATTERS SHOWN ARE NOT TO BE RELIED UPON, OR BE CONSIDERED AS BEING

APPROVED OR IN ACCORDACE WITH APPLICABLE CODES

BD COMMENTS

BD COMMENTS

REVIEW SET

AS NOTED

07/10/2024

NYE

SPECIFICATIONS 1. 4" FPT inlet/outlet with 3" and 4" plain end fittings. 2. Unit weight - 49 lbs. (wet weight 216 lbs.) 3. Maximum operating temperature: Outlet "A" FLOW 150° F continuous (Optional) 4. Capacities - Liquid: 20 gal. Grease: 130 lbs. (17.8 gal.) @35 GPM Grease: 127 lbs. (17.3 gal.) @50 GPM Grease (99% - <u>at least 2 units in series</u>): 180 lbs. (24.7 gal.) @35 GPM Solids: 1.8 gal. 5. Built-in flow control. 6. For gravity drainage applications only. 7. Do not use for pressure applications. 8. Cover placement allows full access to tank for Outlet "B" proper maintenance. (Standard) 9. Vent not required unless per local code. **Outlet Foot** 10. Engineered inlet and outlet diffusers are **Must Face This** removable to inspect/clean piping. Direction In All 11. Integral air relief / anti-siphon. Configurations 12. Designed for indoor, on-floor, below-grade or low-profile under sink installations. Outlet "C"-**ENGINEER SPECIFICATION GUIDE** (Optional) Schier Great Basin™ grease interceptor model # GB2 **TOP VIEW ISOMETRIC VIEW** shall be lifetime guaranteed and made in USA of seamless, rotationally-molded polyethylene with minimum (COVER REMOVED FOR CLARITY) 5/16" uniform wall thickness. Interceptor shall be furnished for above or below grade installation. Interceptor shall be certified to ASME A112.14.3 (type C) and CSA B481.1, with field cut riser system, built-in flow control and three outlet options. Interceptor flow rate shall be 35 or 50 GPM. Interceptor grease capacity shall be 130 lbs. @ 35 GPM or 127 lbs. @ 50 GPM. Cover shall 130 lbs. @ 35 GPM or 127 lbs. @ 50 GPM. Cover shall provide water/gas-tight seal and have minimum 450 lbs. Unlet and Outlet □ See Note #11load capacity. **CERTIFIED PERFORMANCE** Great Basin™ hydromechanical grease interceptors are third party performance-tested and listed by IAPMO to ASME #A112.14.3 and CSA B481.1 13-3/4" grease interceptor standards and greatly exceed 8-3/4" 6-3/4" requirements for grease separation and storage. INVERT They are compliant to the Uniform Plumbing Code, the National Standard Plumbing Code, the National Plumbing Code of Canada, and the International $^-$ Engineered Inlet and $^{-\!-\!-\!-}$ Plumbing Code. -Static Water Line Outlet Diffusers Satisfies Miami DERM 99% efficiency requirements when at least 2 **SECTION A-A END VIEW** units are installed in series. Product labels are permanently attached to inside and outside of unit for easy viewing. SPECIFICATION SHEET SCHIER **PART NUMBER**: 4065-001-05 **MODEL NUMBER:** GB2 **DESCRIPTION:** 6455 Woodland Dr GB2 GREASE INTERCEPTOR 35 GPM / 50 GPM, 4" FPT INLET/OUTLET, WITH Shawnee, KS 66218 3" AND 4" PLAIN END FITTING ADAPTERS AND PEDESTRIAN RATED COVER Tel: 913-951-3300 PROPRIETARY AND CONFIDENTIAL Fax: 913-951-3399 THE INFORMATION CONTAINED IN THIS DRAWING IS THE SOLE PROPERTY OF **SCHIER PRODUCTS**. ANY REPRODUCTION IN PART OR AS A WHOLE WITHOUT THE WRITTEN PERMISSION OF **SCHIER PRODUCTS** IS PROHIBITED. schierproducts.com **DWG BY:** C.SINCLAIR DATE: 5/5/2022 REV: ECO: TABLE 1 – Test Results per ASME A112.14.3-2000 (Reaffirmed 2004) **RER-DERM Summary Block** omechanical FOG Control Device (H-FCD)

	Grease Inter	ceptor					MENTAL		ACCUMULATED			
Test No.	Grease Sink	Water Sink	Drop Time (sec)	Flow Rate (GPM)	Lbs added	Lbs skimmed	Lbs retained	Efficiency (%)	Lbs added	Lbs skimmed	Lbs retained	Efficiency (%)
1	1	2	111	35.9	7	0.00	7.00	100	7	0.00	7.00	100
2	2	1	112	35.6	7	0.00	7.00	100	14	0.00	14.00	100
3	1	2	110	36.3	7	0.02	6.98	99.7	21	0.02	20.98	99.9
4	2	1	112	35.6	7	0.04	6.96	99.4	28	0.06	27.94	99.8
5	1	2	111	35.9	7	0.05	6.95	99.3	35	0.11	34.89	99.7
6	2	1	112	35.6	7	0.05	6.95	99.3	42	0.16	41.84	99.6
7	1	2	111	35.9	7	0.05	6.95	99.3	49	0.21	48.79	99.6
8	2	1	112	35.6	7	0.06	6.94	99.1	56	0.27	55.73	99.5
9	1	2	111	35.9	7	0.05	6.95	99.3	63	0.32	62.70	99.5
10	2	1	111	35.9	7	0.04	6.96	99.4	70	0.36	69.64	99.5
11	1	2	112	35.6	7	0.07	6.93	99.0	77	0.43	76.57	99.4
12	2	1	112	35.6	7	0.05	6.95	99.3	84	0.48	83.52	99.4
13	1	2	112	35.6	7	0.06	6.94	99.1	91	0.54	90.46	99.4
14	2	1	112	35.6	7	0.06	6.94	99.1	98	0.60	97.40	99.4
15	1	2	112	35.6	7	0.05	6.95	99.3	105	0.65	104.35	99.4
16	2	1	112	35.6	7	0.07	6.93	99.0	112	0.72	111.28	99.4
17	1	2	112	35.6	7	0.07	6.93	99.0	119	0.79	118.21	99.3
18	2	1	112	35.6	7	0.08	6.92	98.9	126	0.87	125.13	99.3
19	1	2	111	35.9	7	0.10	6.90	98.6	133	0.97	132.03	99.3
20	2	1	112	35.6	7	0.10	6.90	98.6	140	1.07	138.93	99.2
21	1	2	112	35.6	7	0.11	6.89	98.4	147	1.18	145.82	99.2
22	2	1	112	35.6	7	0.14	6.86	98.0	154	1.32	152.68	99.1
23	1	2	113	35.3	7	0.12	6.88	98.3	161	1.44	159.56	99.1
24	2	1	113	35.3	7	0.16	6.84	97.7	168	1.60	166.40	99.0
25	1	2	113	35.3	7	0.16	6.84	97.7	175	1.76	173.24	99.0
26	2	1	113	35.3	7	0.13	6.87	98.1	182	(1.89)	180.11	99.0
27	1	2	112	35.6	7	0.16	6.84	97.7	189	2.05	186.95	98.9
28	2	1	112	35.6	7	0.15	6.85	97.9	196	2.20	193.80	98.9


Required Information	Tank No. 1	Tank No. 2	Tank No. 3	Tank No. 4
Capacity (gpm)	35 GPM	35 GPM		
FOG Load Capacity (lbs) at 99% Efficiency	18	80		
Manufacturer	Schier	Schier		
Model No.	GB2-2	GB2-2		
3 rd Party Certifier (i.e., PDI, CSA, ASME)	ASME A112.14.3	ASME A112.14.3		
Interceptor Monitoring Alarm Model No.	N/A	N/A		
Interceptor Monitoring Device Model No.	N/A	N/A		
Solid Separator manufacturer and model	Striem Aardvark	Series AA-S		
Sampling port manufacturer and model	Schier SV10			

Updated: 9/8/2022

The FCD, and associated appurtenances on FOG-approved stamped sheets in this set must be installed on site. Equivalent or similar equipment is not accepted by this Division. Should the FOG-approved plan sheets be voided and/or revised, they shall be submitted to the Building Department, and DERM-Grease accordingly for approval.

ALL EQUIPMENT LABELS MUST VISIBLE AT THE TIME OF THE DERM/BUILDING INSPECTION. AND REMAIN VISIBLE THEREAFTER

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NEARBY ENGINEERS
382 NE 191ST STREET SUITE
49674, MIAMI, FL 33179
PH-914.257.3455
WWW.NY-ENGINEERS.COM

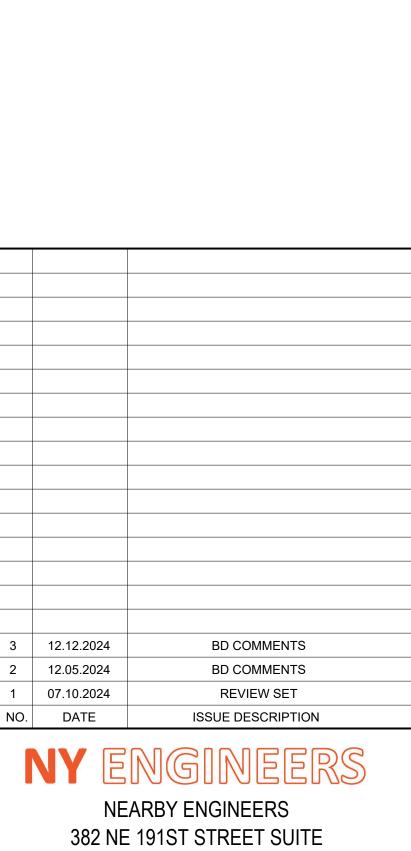Y PLAN		

PROJECT NAME		

PHYSICAL LOCATION

DRAWING TITLE

PLUMBING DETAILS - 1



SCALE AS NOTED

DRAWN BY NYE

CHECKED BY NYE

DATE

07/10/2024


P-3


Report No. 1757-18018 Page **10** of **11**

SPECIFICATION & SUBMITTAL SHEET **MODEL: AA-S**


SMALL BASKET-STYLE SOLIDS INTERCEPTOR

AARDVARK™ SERIES

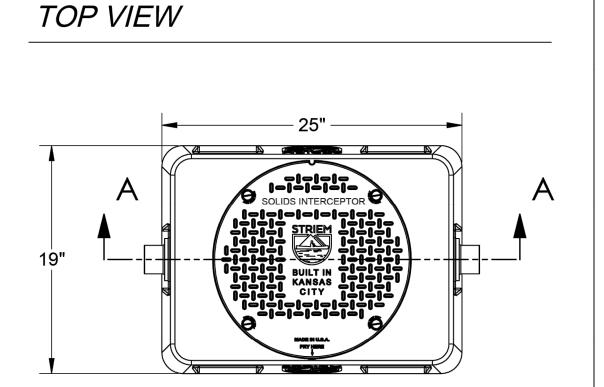

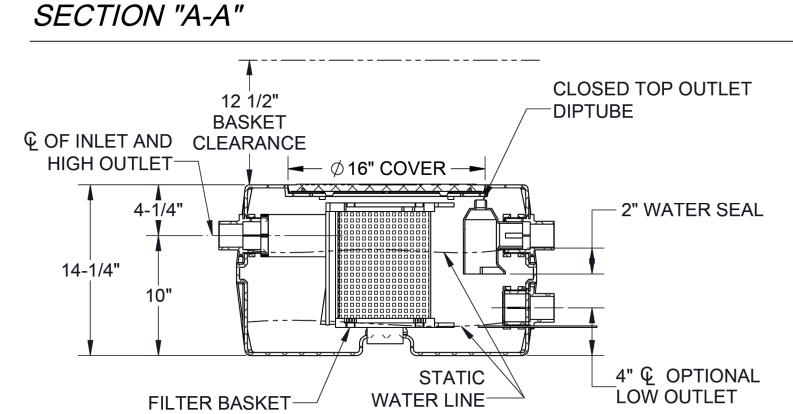

ISOMETRIC VIEW

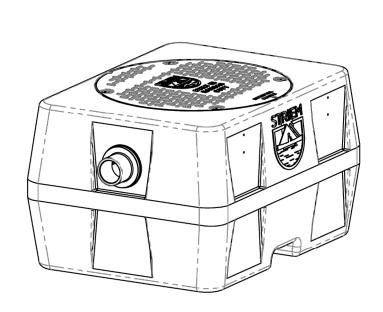

OPTIONS

2M - 2" Male Thread Connections

☐ **3P** - 3" Plain End SCH.40 Connections

3M - 3" Male Thread Connections

SR16 - 2-1/16"-16" 16 Series Riser

CC16 - 2-1/16"-16" 16 Series Riser with Integral Membrane Clamping Collar Kit

RISER ORDER GUIDE						
DESIRED DEPTH	REQUIRED RISER					
> 2-1/8" - 16"	(1) SR - 16					

STANDARD SPECS

CONNECTIONS: 2" SCH. 40 Plain End Connections

LIQUID CAPACITY: With high outlet: 16 gal. With low outlet: 4 gal.

SOLIDS CAPACITY: 2 gal.

FLOW RATE: 35 gpm.

WEIGHT: 42 lbs.

INSTALLATION: Above or below grade.

SEWER GAS TRAP: 2".

COVER LOAD CAPACITY: 450 lbs., or 2,500 lbs. When unit buried directly with SR-16 riser.

MAXIMUM CONTINUOUS OPERATING TEMPERATURE: 140°.

WALL THICKNESS: 3/8".

TANK MATERIAL: Polyethylene.

SCREEN PERFORATIONS: 0.125" Diameter.

INNOVATIONS

- 1 Removable basket interlocks with inlet: prevents solids from escaping basket.
- 2 UNI-FIT™: basket inserts in one orientation.
- 3 All-perforated basket: basket perforations are more than 17 times inlet opening, creating easy flow in the presence of solids, and limiting the chance for a backup.
- 4 Optional low outlet: if used, it allows for a temporary water surge (acts as a reservoir), as well as keeps basket dry during maintenance.
- 5 Movable trap: sewer gas trap can be field-installed on high or low outlet.

ENGINEER SPECIFICATION GUIDE

Striem Aardvark™ solids interceptor model AA-S shall be lifetime guaranteed and made in the USA. Tank material shall be polyethylene. Interceptor shall have removable, corrosion-resistant filter basket. Interceptor shall be equipped with high and low outlet options, with a movable sewer gas trap to be located on either outlet. Interceptor shall be furnished for above- or below-grade installation. Cover shall be water and gas tight with a minimum 450 lbs load capacity, or 2,500 lbs capacity when buried with a riser. Interceptor shall be certified to IAPMO IGC 167-2011ae2.

Specifying Engineer: Signature of Approval: **Engineering Firm:**

PROPRIETARY AND CONFIDENTIAL -THE INFORMATION CONTAINED IN THIS DRAWING IS THE SOLE PROPERTY OF STRIEM, LLC. ANY REPRODUCTION IN PART OR AS A WHOLE WITHOUT THE WRITTEN PERMISSION OF STRIEM, LLC. IS PROHIBITED.

DATE: 02/24/2020 DWG BY: MJ


Date of Approval:



3100 Brinkerhoff Kansas City, KS 66115 рн 913-222-1500 FX 913-291-0457 STRIEMCO.COM

MADE IN THE U.S.A. LIFETIME GUARANTEED



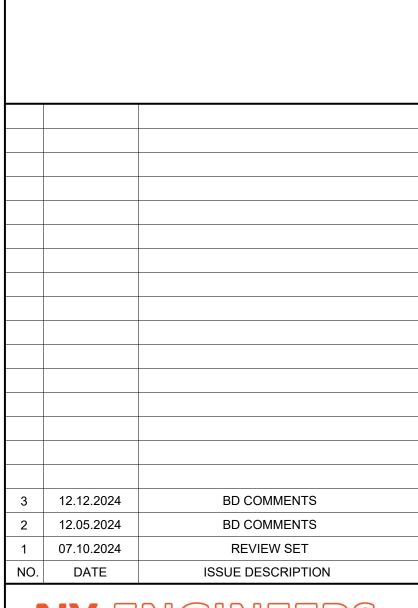

NEARBY ENGINEERS 382 NE 191ST STREET SUITE 49674, MIAMI, FL 33179 PH-914.257.3455 WWW.NY-ENGINEERS.COM

KEY PLAN

PROJECT NAME

PHYSICAL LOCATION


DRAWING TITLE

PLUMBING DETAILS - 2

AS NOTED 07/10/2024

P-4 THIS PLAN IS APPROVED ONLY FOR THE WORK INDICATED ON THE

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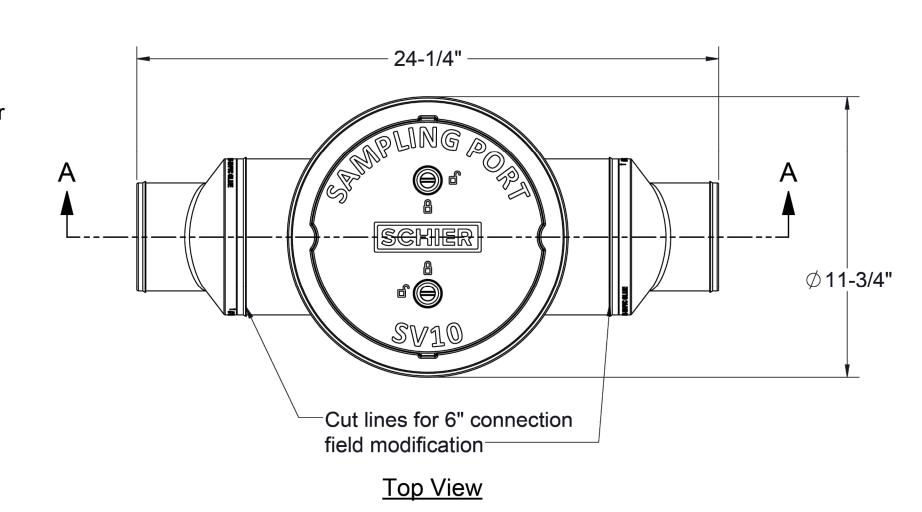
- 1. 4" plain end inlet/outlet
- 2. Field modifiable to 6" plain end inlet/outlet
- 3. Unit weight 9 lbs.
- 4. Maximum operating temperature: 150° F continuous
- 5. Offset connections
- 6. 2 rolls of 33" x 2" butyl mastic tape provided for sealing build-your-own riser joints

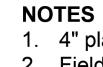
ENGINEER SPECIFICATION GUIDE


Schier Sewer Viewer™ sampling port model # SV10 shall be lifetime guaranteed and madein USA of seamless, rotationally-molded polyethylene. Sampling port shall be furnished for above or below grade installation. Cover shall provide water/gas-tight seal and have minimum 16,000 lbs. load capacity.


ACCESSORIES:

Field Cut Risers for extending cover to grade



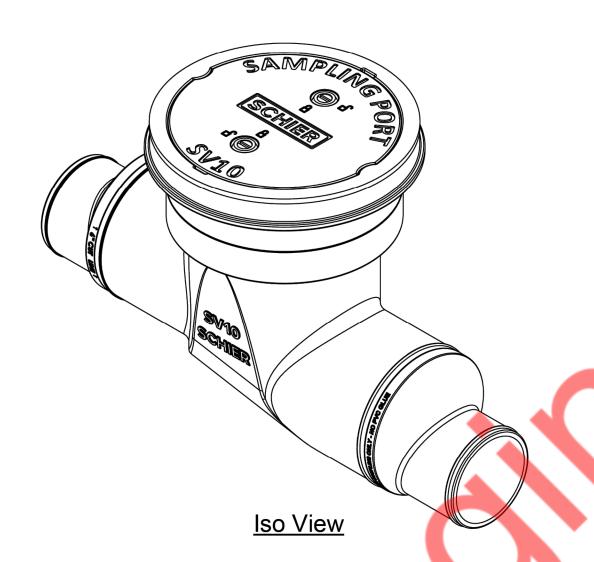

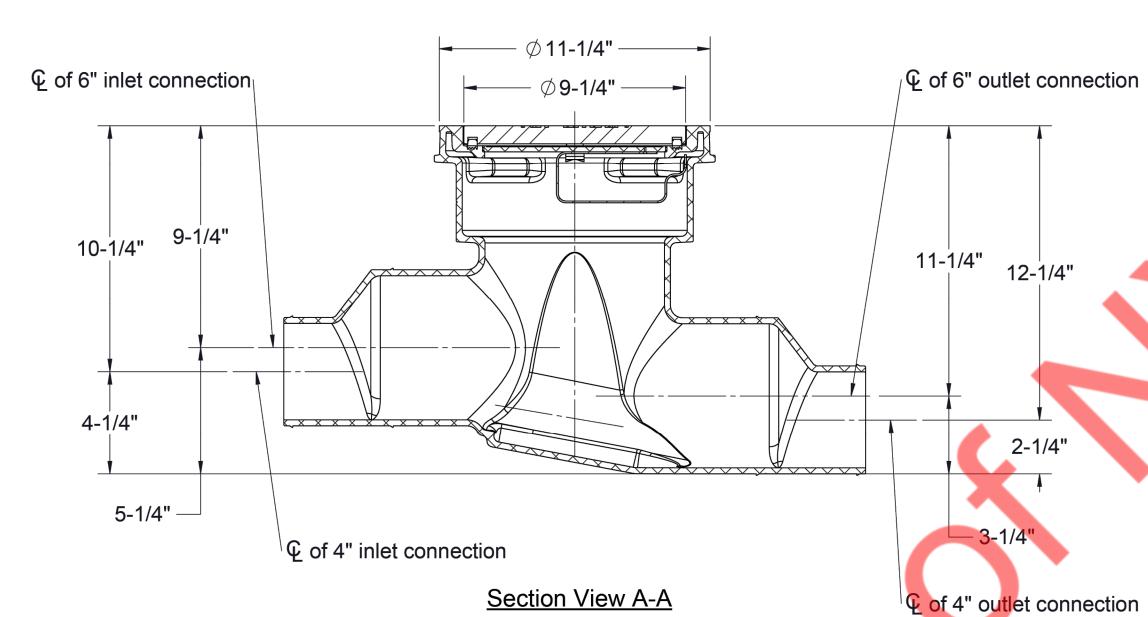

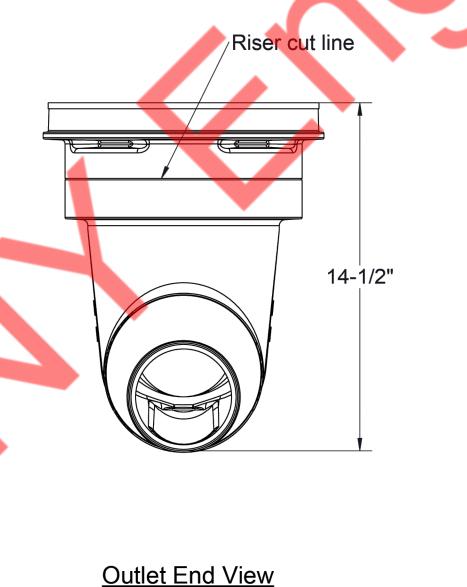

SPECIFICATION SHEET

MODEL NUMBER:

PROHIBITED.

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PART NUMBER: 8065-001-01

DESCRIPTION:

SV10 SEWER VIEWER SAMPLING PORT, 4" CONNECTIONS (FIELD MODIFIABLE TO 6"), POLYETHELENE COVER

6/6/2022 **B.BROWN** REV: DWG BY:

SCHIER

6455 Woodland Dr Shawnee, KS 66218 Tel: 913-951-3300 Fax: 913-951-3399 schierproducts.com

3 12.12.2024 BD COMMENTS 12.05.2024 BD COMMENTS **REVIEW SET** 07.10.2024 ISSUE DESCRIPTION NO. DATE

NY ENGINEERS

NEARBY ENGINEERS 382 NE 191ST STREET SUITE 49674, MIAMI, FL 33179 PH-914.257.3455 WWW.NY-ENGINEERS.COM

KEY PLAN

PROJECT NAME

PHYSICAL LOCATION

DRAWING TITLE

PLUMBING DETAILS - 3

PROJECT NO. AS NOTED NYE 07/10/2024 **P-5**

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